

Planning Commission Study Session

TO: PLANNING COMMISSION/DESIGN REVIEW BOARD

FROM: KEITH NEWMAN, PLANNER II

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THROUGH: CATHERINE LORBEER AICP, PRINCIPAL PLANNER

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MEETING DATE: JUNE 6, 2018

SUBJECT: DR18-56 ALDI

STRATEGIC INITIATIVE: Economic Development

Attract, retain and grow businesses that serve the local and regional customer base as a means to increase Gilbert's sales tax revenue.

REQUEST

DR18-56, ALDI: Site plan, landscaping, grading and drainage, elevations, floor plans, lighting, colors and materials for approximately 8.49 acres, generally located at the southeast corner of Arizona Avenue and Desert Lane, and zoned General Commercial with a Planned Area Development (PAD) overlay.

RECOMMENDED MOTION

Request for input only. No motion required.

APPLICANT/OWNER

Company: Kimley-Horne & Associates Company: N/A

Name: Sterling Margetts Name: Joel Ogden Darner II Address: 1001 W. Southern Ave., #131 Address: 837 W. Main Street

Mesa, AZ 85210 Mesa, AZ 85201

Phone: 480-207-2680 Phone: N/A Email: sterling.margetts@kimley-horn.com Email: N/A

BACKGROUND/DISCUSSION

History

Date	Description
September 18, 1979	Town Council approved A80-02 (Ordinance No. 253), annexing
	approximately 360 acres, including the subject property.
March 3, 1987	Planning Commission approved case S054, Preliminary Plat for
	Fiesta Tech Master Plan Phase II, for Lots 1-6.
November 13, 1997	DRB approved case DR97-65, Hertz Rental Car, on the subject
	property, Parcel 3, Continental Tech Center.

Overview

The applicant is proposing the development of an ALDI retail grocery store, future shops, future pads, and a future light industrial parcel. Currently, a majority of the site is occupied by an abandoned vehicle sales building and associated parking lot, which will be removed to accommodate the proposed development. The site is zoned General Commercial (GC), which supports a broad range of small to large-scale retail, service, office, entertainment, and institutional uses of any size. Through this request, ALDI seeks to receive Design Review approval for the grocery store with a master plan for future phases.

Surrounding Land Use & Zoning Designations:

Surrou	Trounding Land Ose & Zoning Designations.						
	Existing Land Use	Existing Zoning	Existing Use				
	Classification						
North	General Commercial (GC)	General Commercial (GC)	Commercial (Winco and				
			retail pads/shops)				
South	Residential > 14 - 25	Multi-Family Medium	Residential (Sierra Palms				
	DU/Acre	(MF-M)	Apartments)				
East	Light Industrial (LI)	Light Industrial (LI)	Warehousing				
West	Neighborhood Suburban	Multiple Residence (RM-	Residential (Arizona Avenue				
	(City of Mesa)	3)	then San Posada Apartments)				
Site	General Commercial (GC)	General Commercial (GC)	Abandoned car sales lot and				
			building				

Project Data Table

Site Development	Required per LDC	Proposed
Regulations		
Maximum Building Height	45'	29'-6"
Minimum Building Setbacks		
Front	25'	420'
Side to Street	20'	104'
Side to non-residential	20'	N/A
Side to Residential	75'	180'
Rear to non-residential	20'	237'
Minimum Required		
Perimeter Landscape Area		
Front	25'	25'

Side to Street	20'	20'
Side to non-residential	20'	20'
Side to residential	40'	40'
Rear to non-residential	20'	20'
Landscape (% of net lot area)	15%	15%

DISCUSSION:

Staff has recently completed the first review of the project and has provided comments to the applicant. Staff is supportive of the overall development of the project site; however, we have concerns over the use and compatibility of a light industrial building being envisioned along the eastern property boundary. Per the LDC Use Regulations (Table 2.902), light industrial uses are very limited in the GC zoning district and may not be a compatible use with the proposed retail and commercial that is being proposed for the remainder of the site. Staff has asked the applicant to provide additional information concerning said future light industrial use.

Site Plan:

The proposal at this time consists of a 23,435 square foot ALDI grocery store building and associated site improvements on approx. 2.27 acres. It is anticipated that the entire development, which is currently one parcel, will be subdivided into a total of four (4) lots to accommodate the development of two (2) retail pad sites along Arizona Avenue and a light industrial building along the eastern portion of the property. The applicant has not yet submitted applications to subdivide the land so for now it will remain as one parcel. Please note that Design Review Applications for all future buildings and site improvements will be required upon their development.

The entire development will have three (3) vehicular access points once completed. The primary access point exists and is located off of Arizona Avenue at the far southwest corner of the project site. Two (2) secondary access points will be located off of Desert Lane along the north boundary of the property with the western most entrance previously constructed.

The ALDI portion of the development is situated in the middle of the site with parking to the west and north of the building. Vehicle circulation for all vehicles types will take place around the entire building with the truck dock for unloading product to the rear of the site.

Elevations:

The proposed ALDI Building will be 29 feet tall at the highest point and include exterior materials consisting of brick, fiber cement board, stucco, aluminum composite paneling, and glass for all windows. The roof will mainly be flat including parapet roofing at the top of the building with the exception of a raised tower with pitched standing seam metal roofing over the main entryway. The proposed color palette consists of "Earth" tone colors with light tan and two different shades of brown for the main building walls and gray for all steel canopies, standing seam metal roofing and aluminum wall paneling.

Landscaping:

Drought tolerant landscaping will be planted by the site developer with the development of ALDI and include the entire Arizona Avenue and Desert Lane street frontages, onsite areas including required landscape setbacks along the entire perimeter, the ALDI parking lot and along the foundation of the proposed ALDI building. Decorative rock will be used throughout the site as ground cover. The only landscaping that will not be installed by the developer at this time will be all onsite areas associated with the development of the future building/pads The ALDI project will contain 15% landscaping, which meets Town minimum requirements.

Grading and Drainage

On-site retention will be provided in underground and above ground retention basins within the landscape areas along property boundaries and within the parking lots. Town Engineering Staff is in the process of analyzing all proposed site grading and drainage to ensure compliance with all Town standards.

Lighting and Signage:

Wall mounted light fixtures are attached to the building on the north, east and west elevations. 25 foot tall freestanding light poles are proposed on the site throughout the majority of the parking lot to ensure sufficient site lighting and security. Parking lot light poles within 100 feet of the apartment complex to the south will be limited to 14 feet tall.

Three monument sign locations are shown on the master site plan and a design of the signs has not yet been provided to Staff for review. The applicant will be submitting a Comprehensive Sign Plan and signage permits separately as the project continues to develop. Staff will ensure compliance with all sign code requirements.

PUBLIC NOTIFICATION AND INPUT

The proposed project will require public notice as specified under Land Development Code (LDC) Section 5.602.A.3.

REQUESTED INPUT

1. Overall building architecture and site design.

Respectfully submitted,

Keith Newman, Planner II

Attachments and Enclosures:

- 1) Vicinity/Aerial Map
- 2) Site Plan
- 3) Landscape Plan
- 4) Grading and Drainage Plan


- 5) Building Elevations6) Floor Plan7) Lighting Photometric Plan8) Colors and Materials

DR18-56: ALDI

Attachment 1 - Vicinity/Aerial Map

June 6, 2018



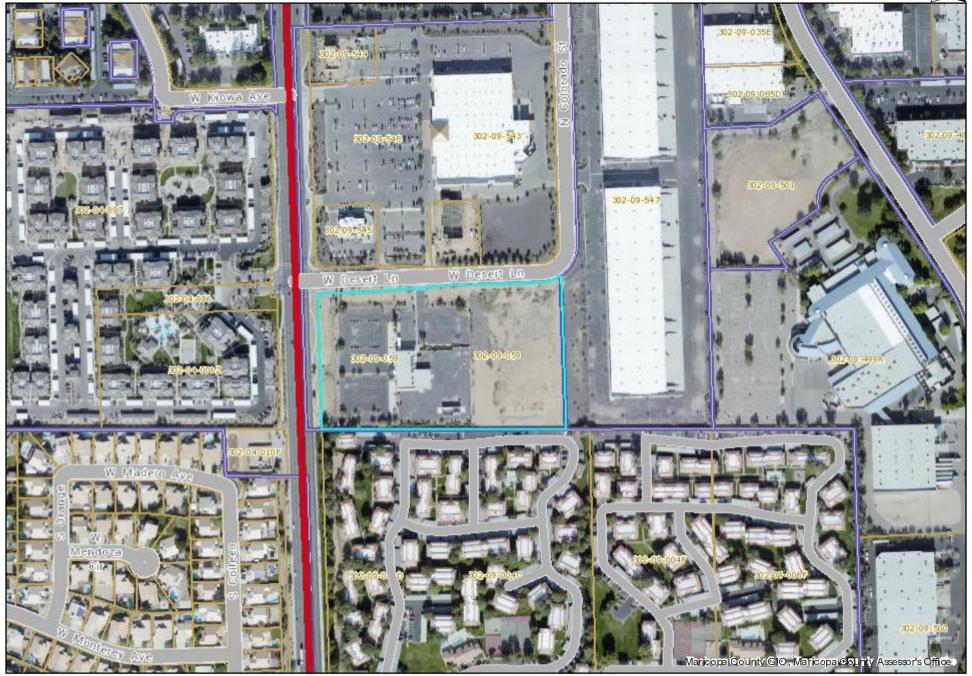

DR18-56: ALDI **Attachment 2 - Site Plan** June 6, 2018

I OVVIN OF GILBERT SITE PLAN NOTES: ALL UTILITY LINES LESS THAN 69 KV ON OR CONTIGUOUS TO THE SITE SHALL BE INSTALLED OR RELOCATED UNDERGROUND. UNDERGROUND.
ALL TRASH ENCLOSURES SHALL INCLUDE FULLY OPAQUE SCREENING GATES, FINISHED AND PAINTED TO MATCH THE ENCLOSURE. SCREENING GATES SHALL NOT OPEN INTO VEHICULAR DRIVE AISLES. TRASH ENCLOSURES ARE NOT REQUIRED IN INDUSTRIAL DISTRICTS IF LOCATED INSIDE AN ENCLOSED YARD WHICH IS SCREENED BY A PERIMETER WALL AT LEAST 6 IN INDUSTRIAL DISTRICTS IF LOCATED INSIDE AN ENCLOSED YARD WHICH IS SCREENED BY A PERIMETER WALL AT LEAST 6 FEET IN HEIGHT.

ALL OUTDOOR STORAGE AREAS FOR STORAGE OF MATERIALS AND EQUIPMENT SHALL BE FULLY SCREENED FROM VIEW BY A 6'SOLID MASONRY WALL. INDUSTRIAL STORAGE SCREEN WALLS SHALL BE FINISHED WHERE THEY ARE EXPOSED TO PUBLIC VIEW FROM STREETS OR ADJACENT NON-INDUSTRIAL USES.

S.E.S. PANELS AND ANY OTHER ABOVE GROUND UTILITY CABINET SHALL BE FULLY SCREENED FROM VIEW FROM STREETS OR FROM AREAS ACCESSIBLE TO CUSTOMERS AND THE GENERAL PUBLIC. SCREENING MAY BE ACCOMPLISHED BY ANY ONE OF THE FOLLOWING METHODS: CABINET;
b) SCREENING WITH A DECORATIVE MASONRY WALL OF THE SAME HEIGHT AS THE PANEL. THE SCREEN WALL MAY BE L-SHAPED, U-SHAPED OR A STRAIGHT WALL PARALLEL TO THE CABINET, DEPENDING ON THE LOCATION OF THE CABIN C) AN ALTERNATIVE SCREENING METHOD APPROVED BY THE PLANNING DEPARTMENT PRIOR TO ISSUANCE OF ANY PERMITS.

a) FULLY RECESSING THE CABINET INTO THE BUILDING AND ENCLOSING IT BY A SOLID DOOR OR DOORS SEPARATE FROM THE

THE LOCATION OF ALL ELECTRICAL UTILITY EQUIPMENT SHALL BE IDENTIFIED ON THE CONSTRUCTION PLANS.
ROOF-MOUNTED MECHANICAL EQUIPMENT SHALL BE FULLY SCREENED BY EITHER ONE OF THE FOLLOWING METHODS:

a) THE PARAPET WALL OF THE BUILDING SHALL EQUAL OR EXCEED THE HEIGHT OF THE MECHANICAL UNITS, OR;
b) BY LOCATING THE MECHANICAL EQUIPMENT BEHIND THE ROOF PLANES IN THE CASE OF MANSARD, HIP OR OTHER THAN FLAT ROOF.

ROOF MOUNTED MECHANICAL EQUIPMENT ENCLOSURES OR EQUIPMENT SCREEN WALLS SHALL NOT PROJECT ABOVE THE ROOF PARAPET. TO THE EXTENT PERMITTED BY LAW, SATELLITE DISHES SHALL BE FULLY SCREENED BY A PARAPET WALL. GROUND MOUNTED MECHANICAL EQUIPMENT SHALL BE FULLY SCREENED FROM VIEW (FROM STREETS OR SURROUNDING COMMERCIAL USES) BY A COMBINATION OF DECORATIVE WALLS AND AN EVERGREEN VEGETATIVE HEDGE EQUAL TO OR EXCEEDING THE HEIGHT OF THE EQUIPMENT.
PNEUMATIC TUBES, WHETHER METAL OR PLASTIC, SHALL BE EITHER:

a) ENCLOSED IN PILASTERS, COLUMNS OR OTHER ARCHITECTURAL FEATURES OF THE CANOPY OR BUILDING, OR; b) ROUTED UNDERGROUND.

10. ALL BACKFLOW PREVENTION DEVICES 2"OR LARGER SHALL BE SCREENED WITH LANDSCAPE LOCATED WITHIN A 6'RADIUS OF THE DEVICE. ALL BACKFLOW PREVENTERS LESS THAN 2"SHALL BE PLACED IN A WIRE CAGE PAINTED TO MATCH THE

ALL FREESTANDING LIGHT POLES SHALL:

a) BE LOCATED WITHIN LANDSCAPED AREAS OR PLANTER ISLANDS.
 b) HAVE CONCRETE BASES PAINTED TO MATCH THE PRIMARY BUILDING COLOR OR FINISHED TO MATCH PARKING SCREEN WALLS. CONCRETE BASES FOR LIGHT POLES SHALL NOT EXCEED A HEIGHT OF 30°FROM ADJACENT GRADE.
 c) BE LOCATED TO AVOID CONFLICT WITH TREES.

12. SITE LIGHTING SHALL COMPLY WITH THE LIGHT AND GLARE CRITERIA SET FORTH IN SECTION 4.103 OF THE LDC, INCLUDING

A MAXIMUM FREESTANDING LIGHT FIXTURE HEIGHT OF 25.

LANDSCAPED AREAS ADJACENT TO PUBLIC RIGHT-OF-WAY SHALL BE MOUNDED AND NATURALLY CONTOURED. NO MORE THAN 50% OF THE REQUIRED (RIGHT-OF-WAY AND LANDSCAPING TRACTS) LANDSCAPING FRONTING ADJACENT STREETS MAY BE USED FOR RETENTION. RETENTION AREA SIDE SLOPES SHALL BE VARIED, AND NO SLOPE SHALL EXCEED A 4:1 13.

MAXIMUM.

COMMERCIAL BUILDING DOWNSPOUTS SHALL BE INTERNALIZED. INDUSTRIAL BUILDINGS MAY USE EXPOSED DOWNSPOUTS IF ARTICULATED WITH THE ARCHITECTURE OF THE BUILDING AND BUILT WITH A DURABLE MATERIAL SUCH AS STEEL. COMMERCIAL DEVELOPMENT VEHICULAR ACCESS POINTS AND PEDESTRIAN ACCESS WAYS SHALL INCLUDE SPECIAL PAVING TREATMENT SUCH AS INTEGRAL COLORED STAMPED CONCRETE, BOAMANITE, OR SMILLAR ALTERNATIVE. LOCATION AND MATERIAL SHALL BE REVIEWED AND APPROVED BY THE PLANNING DEPARTMENT PRIOR TO THE ISSUANCE OF A BUILDING

CUSTOMER, EMPLOYEE AND VISITOR PARKING SHALL BE SCREENED FROM STREET VIEW BY LOW MASONRY.

a) THE PARKING SCREEN WALLS SHALL BE FINISHED ON BOTH SIDES USING THE SAME MATERIALS AND COLORS, AND A DESIGN TO COMPLEMENT THAT OF THE MAIN BUILDING.

ALL EXTERIOR METAL SHALL BE FINISHED OR PAINTED TO MATCH THE APPROVED PROJECT COLORS.
EXISTING ON-SITE PLANT MATERIAL DAMAGED DURING CONSTRUCTION SHALL BE REPLACED WITH COMPARABLE SPECIES

SHEET INDEX				
SHEET NUMBER	SHEET TITLE			
1	COVER SHEET			
2	SITE PLAN			

PROJECT DESCRIPTION

BENCHMARK

DRAINAGE STATEMENT:

THE PROPOSED DEVELOPMENT WILL RETAIN ALL ON-SITE AND ADJACENT HALF-STREET FLOWS GENERATED FROM THE 50-YEAR 24-HOUR STORM IN SURFACE AND UNDERGROUND RETENTION BASINS PER TOWN OF GILBERT PUBLIC WORKS AND ENGINEERING STANDARDS.

THE LAND REFERRED TO HEREIN BELOW IS SITUATED IN GILBERT, IN THE COUNTY OF MARICOPA, STATE OF ARIZONA, AND IS DESCRIBED AS FOLLOWS:

LOT 1, OF FIESTA TECH MASTER PLAN PHASE II, ACCORDING TO BOOK 310 OF MAPS, PAGE 12, AND CERTIFICATE OF CORRECTION RECORDED AUGUST 25, 1987 IN RECORDING NO. 87-533386, RECORDS OF MARICOPA COUNTY, ARIZONA.

SITE PLAN **GROCERY STORE**

1225 N ARIZONA AVENUE GILBERT, AZ 85233


A PORTION OF THE NORTHWEST QUARTER OF SECTION 3, TOWNSHIP 1 SOUTH, RANGE 5 EAST OF THE GILA AND SALT RIVER BASE AND MERIDIAN, MARICOPA COUNTY, ARIZONA

SITE CALCULATIONS

SEC OF COUNTRY CLUB DRIVE & DESERT LANE, GILBERT, AZ ADDRESS:

EXISTING ZONING: PROPOSED ZONING: ADJACENT ZONING: GC GC, MF/M

PROPOSED ALDI LOT AREA PROPOSED ALDI LOT AREA PAD 1 LOT AREA: PAD 2 LOT AREA: SHOPS AREA: INDUSTRIAL PARCEL AREA: TOTAL LOT AREA:

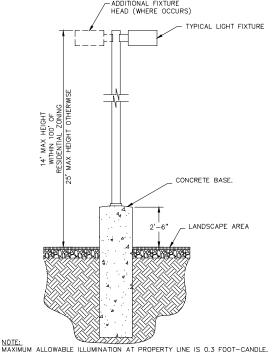

BASELINE ROAD ESERT LN SITE GUADALUPE ROAD VICINITY MAP

DEVELOPER/OWNER

ALDI, INC. 5080 N. 40TH STREET, SUITE 335 PHOENIX, AZ 85018
TEL NO. (602) 888-8931
CONTACT: DAVE LAMBERT
EMAIL: DAVID.LAMBERT@ALDI.US

ENGINEER

KIMLEY-HORN AND ASSOCIATES, INC. 1001 WEST SOUTHERN AVE. SUITE 131 MESA, ARIZONA 85210 MESA, ANIZUNA 63210 TEL NO. (480) 207-2666 CONTACT: STERLING MARGETTS EMAIL: STERLING.MARGETTS@KIMLEY—HORN.COM




ARIZONA


GILBERT,

COVER SHEET

Kimley»Horn

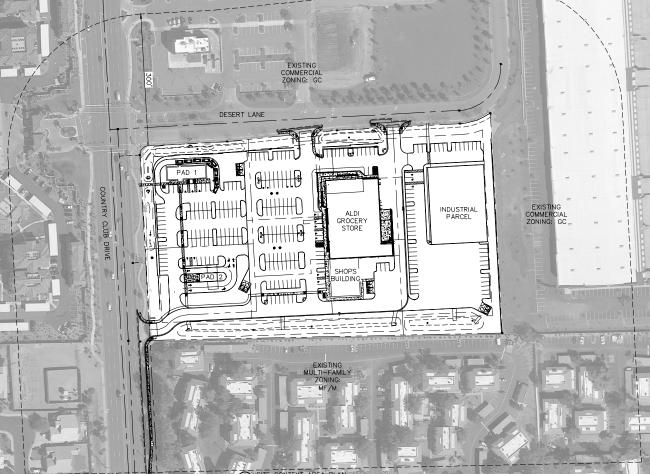



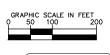





291162008

SCALE (H): 1":100

SCALE (V): NONE

C1

THE SCOPE OF THIS PROJECT CONSISTS OF A NEW 22,435 SQUARE FOOT ALDI GROCERY STORE BUILDING, FUTURE PADS, FUTURE INDUSTRIAL, FUTURE SHOPS, AND ASSOCIATED SITE IMPROVEMENTS IN GILBERT, ARIZONA. THE OVERALL SITE, 8.50± ACRES, IS BOUNDED BY DESERT LANE TO THE NORTH, GENERAL COMMERCIAL TO THE EAST, MULTI-FAMILY TO THE SOUTH, AND COUNTRY CLUB DRIVE TO THE WEST.

THE PROPOSED ESTABLISHMENT IS A GROCERY STORE AND FUTURE OUTPARCELS (PADS AND STORAGE). THE CURRENT ZONING FOR THE SITE IS GENERAL COMMERCIAL (GC). THE ZONING TO THE NORTH AND EAST IS IS GENERAL COMMERCIAL (GC). THE ZONING TO THE SOUTH OF THE SITE IS MULTI-FAMILY RESIDENCE (MF/M).

THE PROPOSED DEVELOPMENT WILL RETAIN THE 50-YR 24-HR STORM EVENT ON-SITE IN UNDERGROUND STORAGE PIPES IN THE PARKING AREA AND SURFACE BASINS AROUND THE PERIMETER THAT WILL DRAIN VIA DRYWELLS WITHIN 36 HOURS.


ACCORDING TO THE FLOOD INSURANCE RATE MAP #04013C2727L, DATED 11/04/2015, THIS PROPERTY IS LOCATED IN FLOOD ZONE "X." AREAS OF 0.2% ANNUAL CHANCE FLOOD; AREAS OF 1% ANNUAL CHANCE FLOOD WITH AVERAGE DEPTHS OF LESS THAN 1 FOOT OR WITH DRAINAGE AREAS LESS THAN 1 SQUARE MILE; AND AREAS PROTECTED BY LEVEES FROM 1% ANNUAL CHANCE FLOOD.

THE CITY OF MESA BRASS CAP IN HANDHOLE STAMPED "CITY OF MESA", MARKING THE NORTH QUARTER OF SECTION 34, TOWNSHIP 1 NORTH, RANGE 5 EAST, G@SRBM. TOWN OF GILBERT DATUM. ELEVATION = 1213.60 (NAVD '88)

BASIS OF BEARING

THE LINE BETWEEN A CITY OF MESA BRASS CAP IN HANDHOLE MARKING THE WEST QUARTER CORNER OF SECTION 3, TOWNSHIP 1 SOUTH, RANGE 5 EAST, AND A CITY OF MESA BRASS CAP IN HANDHOLE MARKING THE INTERSECTION OF S. COUNTRY CLUB DRIVE AND DESERT LANE.
SAID LINE BEARS NORTH 2 DEGREES 50 MINUTES 10 SECONDS WEST.

LEGAL DESCRIPTION

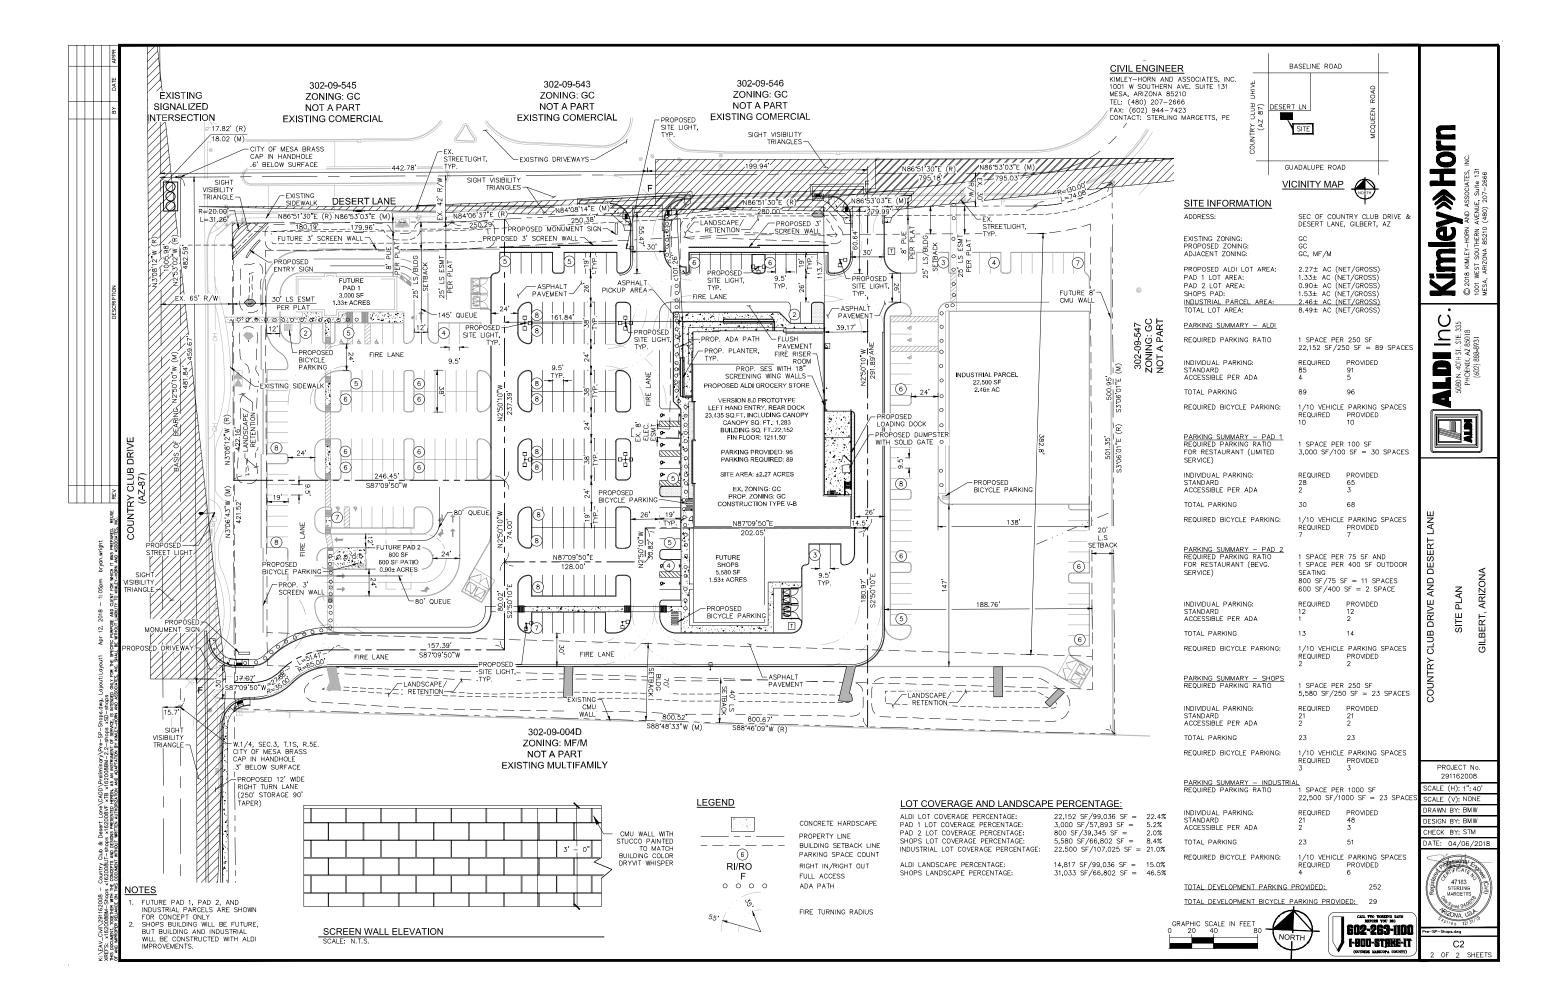

GENERAL LANDSCAPE NOTES

- 1. ALL WORK SHALL BE CONFINED TO LIMITS OF CONSTRUCTION AS SHOWN ON PLANS.
- 2. SITE GRADING NECESSITATED BY THE WORK AS IT PROGRESSES AND NOT SPECIFICALLY CALLED OUT ON THE
- 3. CONTRACTOR SHALL COORDINATE AND BE IN COMPLIANCE WITH ALL STATE AND LOCAL MUNICIPALITIES AS
- 4. CONTRACTOR IS TO REVIEW PLANS, VERIFY SITE CONDITIONS AND PLANT QUANTITIES PRIOR TO INSTALLATION. ANY DISCREPANCIES FOUND BETWEEN THE DRAWINGS AND SPECIFICATIONS AND EXISTING SITE CONDITIONS OR ANY INCONSISTENCIES OR AMBIGUITIES IN DRAWINGS OR SPECIFICATIONS SHALL BE IMMEDIATELY REPORTED TO THE LANDSCAPE ARCHITECT, IN WRITING, WHO SHALL PROMPTLY ADDRESS SUCH INCONSISTENCIES OR AMBIGUITIES. WORK DONE BY THE CONTRACTOR AFTER HIS DISCOVERY OF SUCH DISCREPANCIES, INCONSISTENCIES, OR AMBIGUITIES SHALL BE DONE AT THE CONTRACTOR'S RISK.
- 5. DEVIATION FROM THESE PLANS AND NOTES WITHOUT THE PRIOR CONSENT OF THE OWNER, OR THE LANDSCAPE ARCHITECT MAY BE CAUSE FOR THE WORK TO BE DESIGNATED UNACCEPTABLE.
- 6. THE CONTRACTOR ACKNOWLEDGES & AGREES THAT THE WORK IS ENTIRELY AT HIS RISK UNTIL SITE IS ACCEPTED, AND HE WILL BE HELD RESPONSIBLE FOR ITS SAFETY BY THE OWNER.
- 7. THE CONTRACTOR WILL BE HELD RESPONSIBLE FOR THE DAMAGE OR LOSS OF ANY REFERENCE POINTS AND HUBS DURING THE CONSTRUCTION OF HIS WORK, AND SHALL BEAR THE COST OF REPLACING SAME.
- 8. THE CONTRACTOR IS RESPONSIBLE FOR HORIZONTALLY AND VERTICALLY LOCATING AND PROTECTING ALL PUBLIC AND PRIVATE UTILITIES WHICH LIE IN OR ADJACENT TO THE CONSTRUCTION SITE AT LEAST 48 HOURS PRIOR TO ANY DEMOLITION, GRADING, OR CONSTRUCTION ACTIVITY.
- THE CONTRACTOR SHALL SALVAGE AND PROTECT ALL EXISTING POWER POLES, SIGNS, MANHOLES, TELEPHONE RISERS, WATER VALVES, ETC., DURING ALL CONSTRUCTION PHASES UNLESS NOTED OTHERWISE. THE CONTRACTOR SHALL REPAIR, AT HIS OWN EXPENSE, ANY EXISTING UTILITIES DAMAGED DURING CONSTRUCTION.
- 10. ANY FOREIGN ITEM FOUND DURING CONSTRUCTION IS THE PROPERTY OF THE OWNER, THIS INCLUDES, BUT IS NOT LIMITED TO, PRECIOUS METALS, COINS, PAPER CURRENCY, ARTIFACTS AND ANTIQUITIES.
- 11. ALL SURPLUS EXCAVATION SHALL BE TAKEN TO A SITE DESIGNATED BY OWNER, AT NO ADDITIONAL COST TO THE OWNER IF OWNER CHOOSES, THE CONTRACTOR MAY TAKE POSSESSION OF SURPLUS EXCAVATION
- 12. CONTRACTOR IS RESPONSIBLE FOR VERIFYING AND/OR OBTAINING ALL REQUIRED PERMITS AND APPROVALS PRIOR TO COMMENCING CONSTRUCTION.
- 13. CONTRACTOR IS TO MAINTAIN CONTROLLED PEDESTRIAN AND ADA ACCESS THROUGH ALL AREAS OF THE SITE THROUGHOUT CONSTRUCTION PERIOD.
- 14. MAINTAIN THE SITE IN A NEAT AND ORDERLY CONDITION AT ALL TIMES. DAILY, AND MORE OFTEN IF NECESSARY, INSPECT & AND PICK UP ALL SCRAP, DEBRIS, & WASTE MATERIAL.
- 15. IT IS THE RESPONSIBILITY OF THE CONTRACTOR TO REMOVE ALL MUD, DIRT, ROCK MULCH AND OTHER MATERIALS TRACKED ONTO ANY PRIVATE OR PUBLIC STREETS OR SIDEWALKS. THE CONTRACTOR MUST CLEAN THESE DAILY, IF NECESSARY. THE CONTRACTOR MUST USE WATER OR OTHER ACCEPTABLE METHODS TO KEEP AIRBORNE DUST TO A REQUIRED MINIMUM.
- 16. PROVIDE PROTECTION TO ALL FINISHED WORK, MAINTAIN SURFACES CLEAN, UNMARRED, AND SUITABLY PROTECTED UNTIL ACCEPTANCE BY OWNER.
- 17. THE CONTRACTOR SHALL BE RESPONSIBLE FOR REPAIRING ANY DAMAGE RESULTING FROM CONSTRUCTION ACTIVITY TO EXISTING ELEMENTS THAT ARE TO REMAIN.
- 18. EROSION CONTROL MEASURES (IE: SILT FENCING AND SEDIMENT CONTROL) SHALL BE MAINTAINED BY THE CONTRACTOR PER CIVIL SPECIFICATIONS. ANY EROSION CONTROL MEASURES DAMAGED BY THE CONTRACTOR SHALL BE REPLACED PER CIVIL SPECIFICATIONS.
- 19. PLANT QUANTITIES LISTED IN THE PLANT LEGEND ARE FOR THE CONVENIENCE OF THE CONTRACTOR. THE CONTRACTOR SHALL DO THEIR OWN TAKE-OFFS AND BASE BID ACCORDINGLY.
- 20. ALL PLANT MATERIAL SHALL BE HEALTHY, VIGOROUS, WELL BRANCHED, AND DENSELY FOLIATED (WHEN IN-LEAF) AS IS TYPICAL FOR THE SPECIES. THEY SHALL HAVE HEALTHY, WELL DEVELOPED STANDARDS, AND FREE OF ANY BRUISES, CUTS OR OTHER ABNORMALITIES. PLANT MATERIAL SHALL BE SIZED IN ACCORDANCE WITH THE AMERICAN STANDARD FOR NURSERY STOCK, LATEST EDITION, PUBLISHED BY THE AMERICAN ASSOCIATION OF NURSERYMAN.
- 21. OWNERS REPRESENTATIVE RESERVES THE RIGHT TO REJECT ANY PLANT MATERIAL DEEMED UNACCEPTABLE.
- 22. LANDSCAPE CONTRACTOR TO TAG AND HOLD ALL PLANT MATERIAL A MINIMUM OF 30 DAYS PRIOR TO DATE OF INSTALLATION. ALL PLANT MATERIAL SUBSTITUTIONS MADE WITHIN THE 30 DAYS PRIOR TO INSTALLATION TO BE THE NEXT SIZE LARGER AT NO ADDITIONAL COST TO THE CLIENT.
- 23. ALL TREE LOCATIONS TO BE STAKED AND APPROVED BY THE OWNER'S REPRESENTATIVE PRIOR TO
- 24. INSTALL ALL CANOPY TREES WITH A MINIMUM OF 5 FT. SEPARATION FROM ALL UTILITIES, UNLESS A ROOT
- 25. THE LANDSCAPE CONTRACTOR SHALL MAINTAIN PLANTED AREAS BY MEANS OF CONTINUOUS WATERING, PRUNING, RAISING TREE ROOT BALLS WHICH SETTLE BELOW GRADE, APPLICATION OF SPRAYS WHICH ARE NECESSARY TO KEEP THE PLANTING FREE OF INSECTS AND DISEASES, FERTILIZING, WEEDING, MOVING,
- 26. ROCK MULCH: ALL AREAS LABELED ROCK MULCH ON THE PLANS ARE TO BE APPROVED BY OWNER. 2" MINIMUM DEPTH THROUGHOUT ENTIRE PROJECT. FINISH GRADE IN ALL AREAS TO BE SMOOTH AND EVEN AND 1" BELOW

PLANTING LEGEND

TREES			
_	BOTANICAL NAME / COMMON NAME	SIZE	<u>QTY</u>
	Acacia salicina Willow Acacia	1½" Cal. Min., 8' Ht. Min., 4' Spread Min., 24" Box Min.	49
	Chilopsis linearis 'Lucretia Hamilton' Desert Willow	$1\frac{1}{4}$ " Cal. Min., 7' Ht. Min., 4' Spread Min., 24" Box Min.	8
(^)	Parkinsonia 'Desert Museum' Desert Museum Palo Verde	1½" Cal. Min., 8' Ht. Min., 4' Spread Min., 24" Box Min.	30
\mathcal{L}	Pinus eldarica Mondel Pine	2" Cal. Min., 10' Ht. Min., 4' Spread Min., 24" Box Min.	62
	Ulmus parvifolia Evergreen Elm	1¼" Cal. Min., 8' Ht. Min., 3' Spread Min., 24" Box Min.	63
		BOTANICAL NAME / COMMON NAME Acacia salicina Willow Acacia Chilopsis linearis 'Lucretia Hamilton' Desert Willow Parkinsonia 'Desert Museum' Desert Museum Palo Verde Pinus eldarica Mondel Pine Ulmus parvifolia	BOTANICAL NAME / COMMON NAME Acacia salicina Willow Acacia Chilopsis linearis 'Lucretia Hamilton' Desert Willow Parkinsonia 'Desert Museum' Desert Museum Palo Verde Pinus eldarica Mondel Pine Ulmus parvifolia BOTANICAL Min., 8' Ht. Min., 4' Spread Min., 24" Box Min. 1½" Cal. Min., 7' Ht. Min., 4' Spread Min., 24" Box Min. 2" Cal. Min., 10' Ht. Min., 4' Spread Min., 24" Box Min. 1½" Cal. Min., 10' Ht. Min., 4' Spread Min., 24" Box Min.

	BOTANICAL NAME / COMMON NAME	SIZE	QTY
*	Agave parryi var. truncata Artichoke Agave	12" Ht. Min. 12" Width Min.	5
*	Agave geminiflora Twin-Flowered Agave	12" Ht. Min. 12" Width Min.	5
*	Agave americana 'Mediopicta Alba' White Striped Century Plant	16" Ht. Min. 16" Width Min.	7
\bigcirc	Bougainvillea 'La Jolla' La Jolla Bougainvillea	5 Gal.	29
9	Caesalpinia pulcherrima Red Bird of Paradise	5 Gal.	49
0	Callistemon viminalis 'Little John' Little John's Bottlebrush	5 Gal.	71
⊗	Eremophila hygrophana Blue Bells	5 Gal.	45
*	Hesperaloe funifera Giant Yucca	5 Gal.	19
*	Hesperaloe parviflora 'perpa' Brakelights Red Yucca	5 Gal.	78
0	Leucophyllum frutescens 'Compacta' Compact Texas Ranger Sage	5 Gal.	75
\otimes	Leucophyllum frutescens 'Green Cloud' Green Cloud Sage	5 Gal.	131
31/4	Muhlenbergia rigens Deer Grass	5 Gal.	111
•	Muhlenbergia rigida 'Nashville' Nashville Muhly Grass	5 Gal.	60
	Tecoma alata 'Orange Jubilee' Orange Jubilee	5 Gal.	26
\odot	Tecoma stans 'Gold Star' Yellow Bells	5 Gal.	118
GROUNE	COVERS		
	BOTANICAL NAME / COMMON NAME	SIZE	QTY
0	Lantana camara 'New Gold' New Gold Lantana	1 Gal.	125
Ð	Lantana montevidensis Purple Trailing Lantana	1 Gal.	254
0	Ruellia brittoniana 'Katie' Katie Ruellia	5 Gal.	49

	DESCRIPTION
27.75	Decomposed (
100000000000000000000000000000000000000	3/." Screened

MATERIALS

262.700 SF Decomposed Granite (Submit Sample to Owner for Approval) 3/4" Screened, Express Brown by Granite Express, 2" Depth Min.

TOWN OF GILBERT LANDSCAPE REQUIREMENTS

REQUIRED	PROVIDED	REQUIRED	PROVIDED
Parking Lot Landscape Screening Wall or 3'-4' Evergreen Vegetative Screen Not Located within R.O.W 3'-6' Offset from Parking Area Max. 24' ht. Vegetation in Visibility Triangle	Provided Provided Provided Provided	All Landscape Areas Not Covered by Turf, or Hardscape Shall be Covered by Approved Inorganic Groundcover such as D.G. Depth of Coverage Shall be Indicated on LS Plan Parking Lot Landscape	Provided, Depth Indicated in Legend
Parking Lot Landscape 1 Tree / 8 Spaces (16 Trees) Min. Trunk ht. 6', 2" Caliper	32 Trees 6' ht. Min., 2" Caliper	121 Spaces / 8 = 16 Trees Required Streescape Right of Way Planting 1 Tree / 25 LF, 3 Shrubs per Tree	32 Trees Provided
Min. 10% Landscape (5,980 SF) Max. 8 Spaces without Planter	11.6% or 6,940 SF Provided	735 LF (Desert Ln.) / 25 = 30 Trees / 90 Shrubs 407 LF (Country Club) / 25 = 17 Trees / 51 Shrubs	30 Trees / 90 Shrub 17 Trees / 51 Shrub
Landscape Regulations All Trees Min. 6' ht. Palm Trees Min. 5' ht. All Trees Min. 3' ht. All Trees Min. 3'4" Caliper Trees Shall Be Planted Per ANA Standards	Provided N/A Provided Details will be Provided with CD Submittal	Side and Perimeter Landscape Areas 3 Trees / 1000 SF, 5 Shrubs / 1000 SF 29,990 SF (South) x 3 / 1000 = 90 Trees / 150 Shrubs 9,310 SF (East) x 3 / 1000 = 30 Trees / 50 Shrubs Groundcover 20% of Area Required Retention Basins Completely Landscaped Max. 4:1 Slope in Retention Basins	90 Trees / 150 Shrub 30 Trees / 50 Shrub Provided Provided 4:1 Provided
		Streetscape Theme Trees - by District, 50% (District 1)	Mondel Pine (50%+

QTY



DEVELOPER/OWNER

ALDI, INC. 5080 N. 40TH STREET, SUITE 335 PHOENIX, AZ 85018

CIVIL ENGINEER

LANDSCAPE ARCHITECT

KIMLEY-HORN AND ASSOCIATES, 7740 N. 16th STREET, SUITE 300

PHOENIX, ARIZONA 85020
TEL. NO. (602) 906-1103
CONTACT: ANDREW VALESTIN, PLA
EMAIL: ANDREW.VALESTIN@KIMLEY-HORN.COM

<u>ARCHITECT</u>

MS CONSULTANTS, INC.
2221 SCHROCK ROAD
COLUMBUS, 0H 43229
PH: 614-898-7100
CONTACT: JASON LONGBRAKE
EMAIL: JLONGBRAKE@MSCONSULTANTS.COM









COVER LANDSCAPE GILBERT,

COUNTRY

291162008


SCALE (H): NONE SCALE (V): NONE DRAWN BY: RAS DESIGN BY: AAV CHECK BY: AAV



Expires 09/30/2018

602-263-1100 1-800-STAKE-IT

LC1

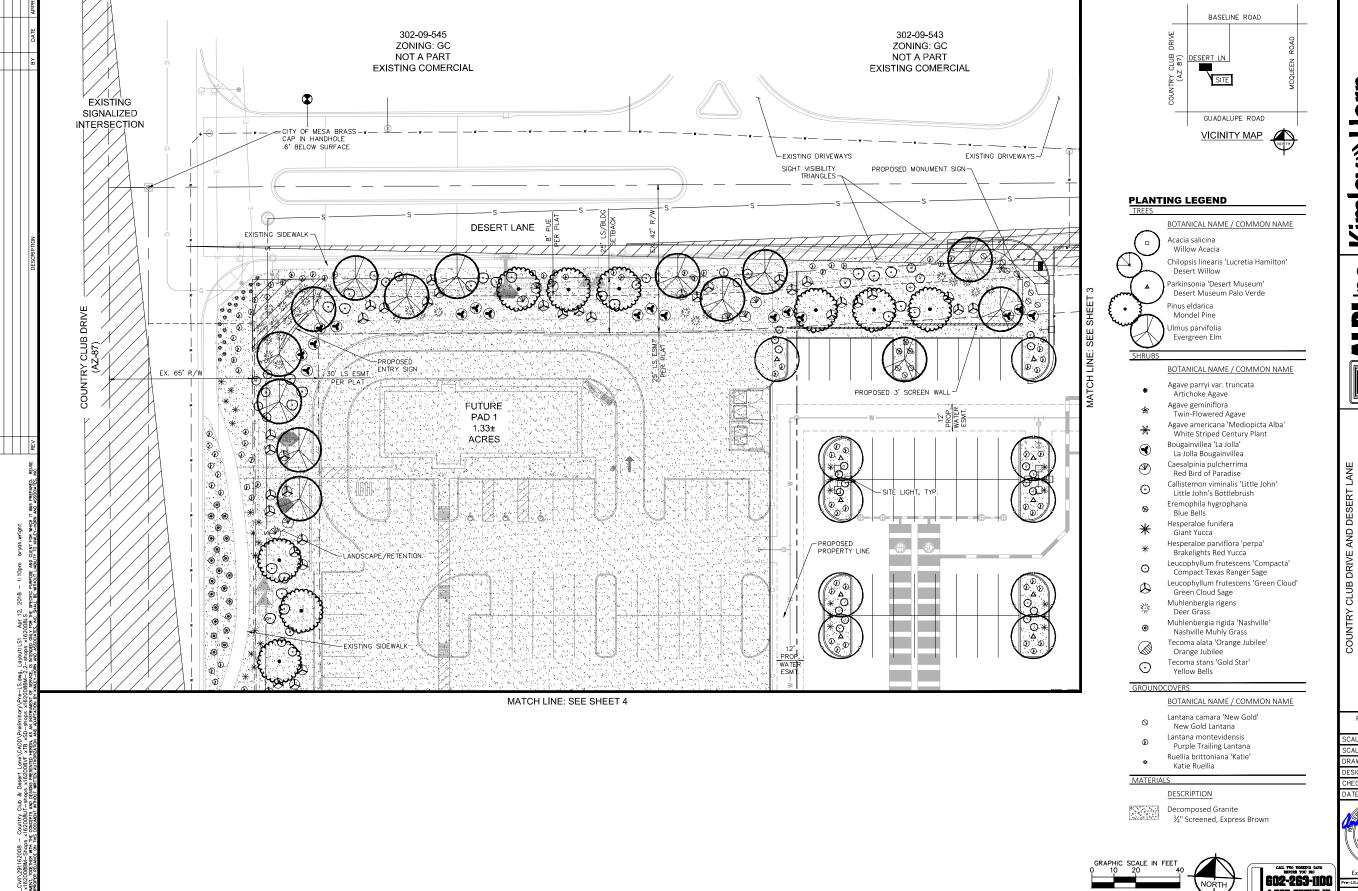

Kimley» Horn
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5080 N. 40TH SI. SIE. 335 PHOCHIX AZ 85018 (ARY) 808-8931

PRELIMINARY LANDSCAPE

GILBERT, ARIZONA


291162008

SCALE (H): 1": 20' SCALE (V): NONE DRAWN BY: RAS DESIGN BY: AAV

CHECK BY: AAV DATE: 04/06/201

Expires 09/30/2018 LS1

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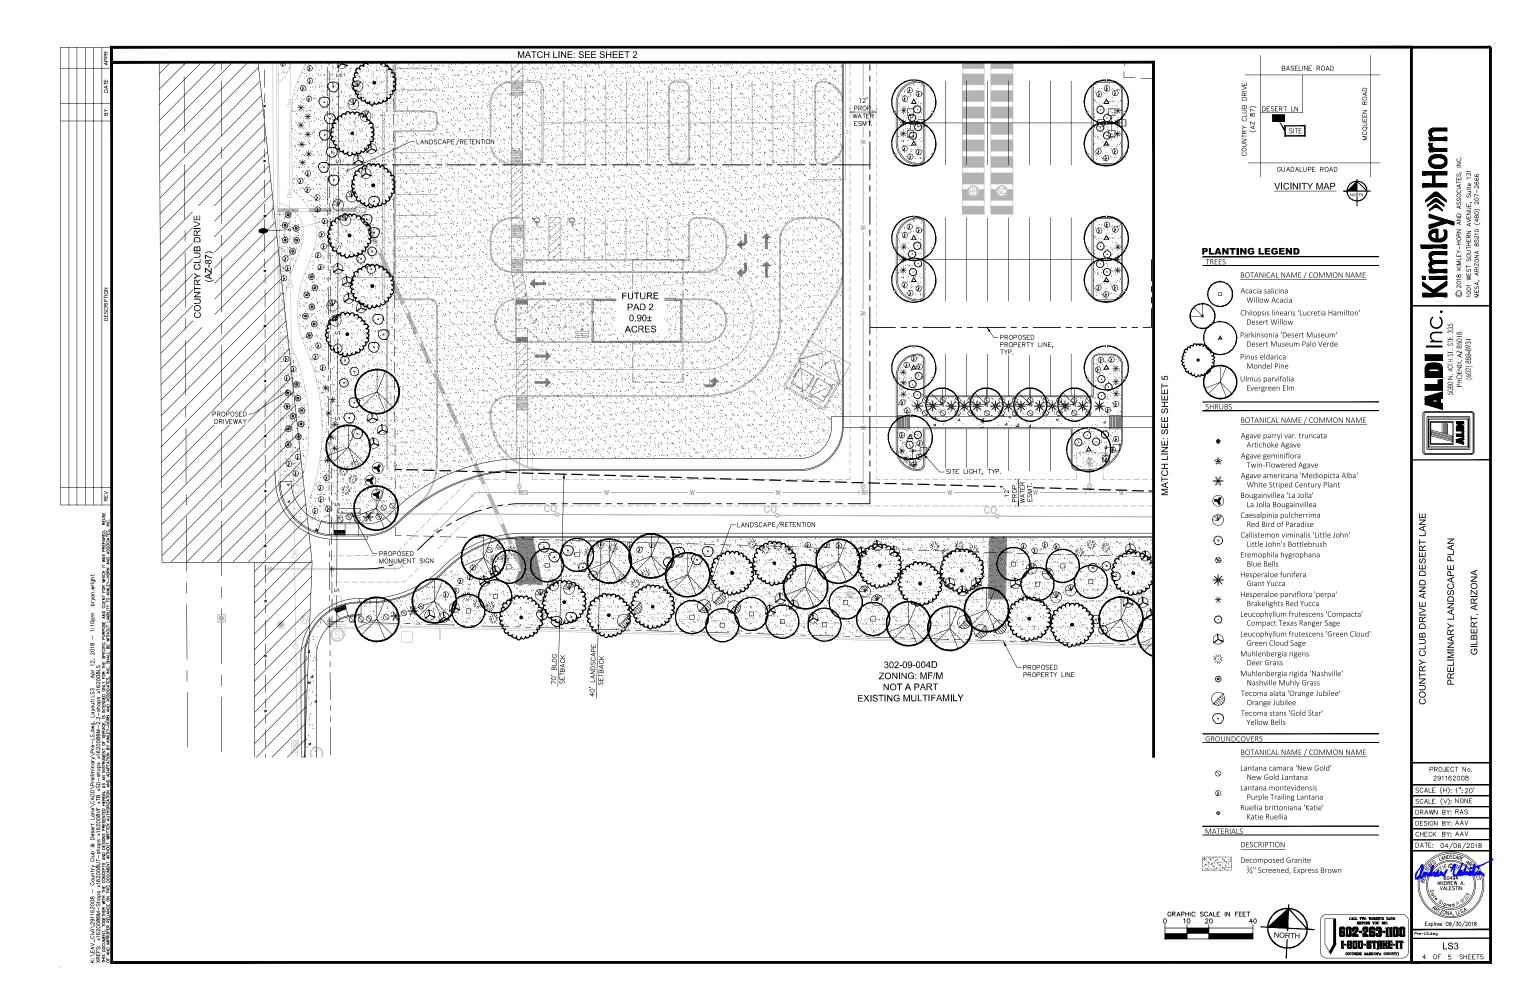


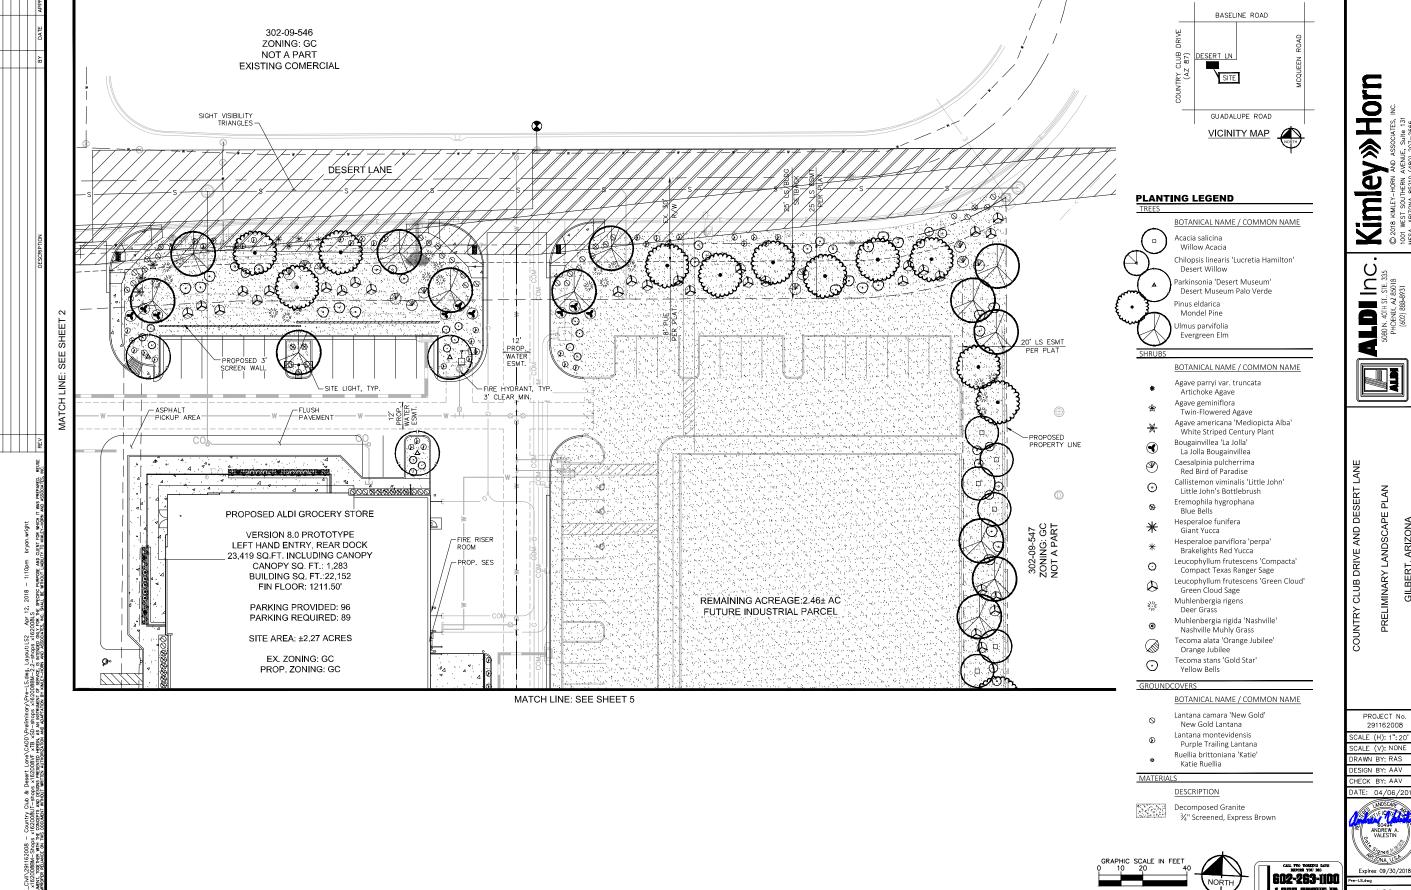
GILBERT, ARIZONA









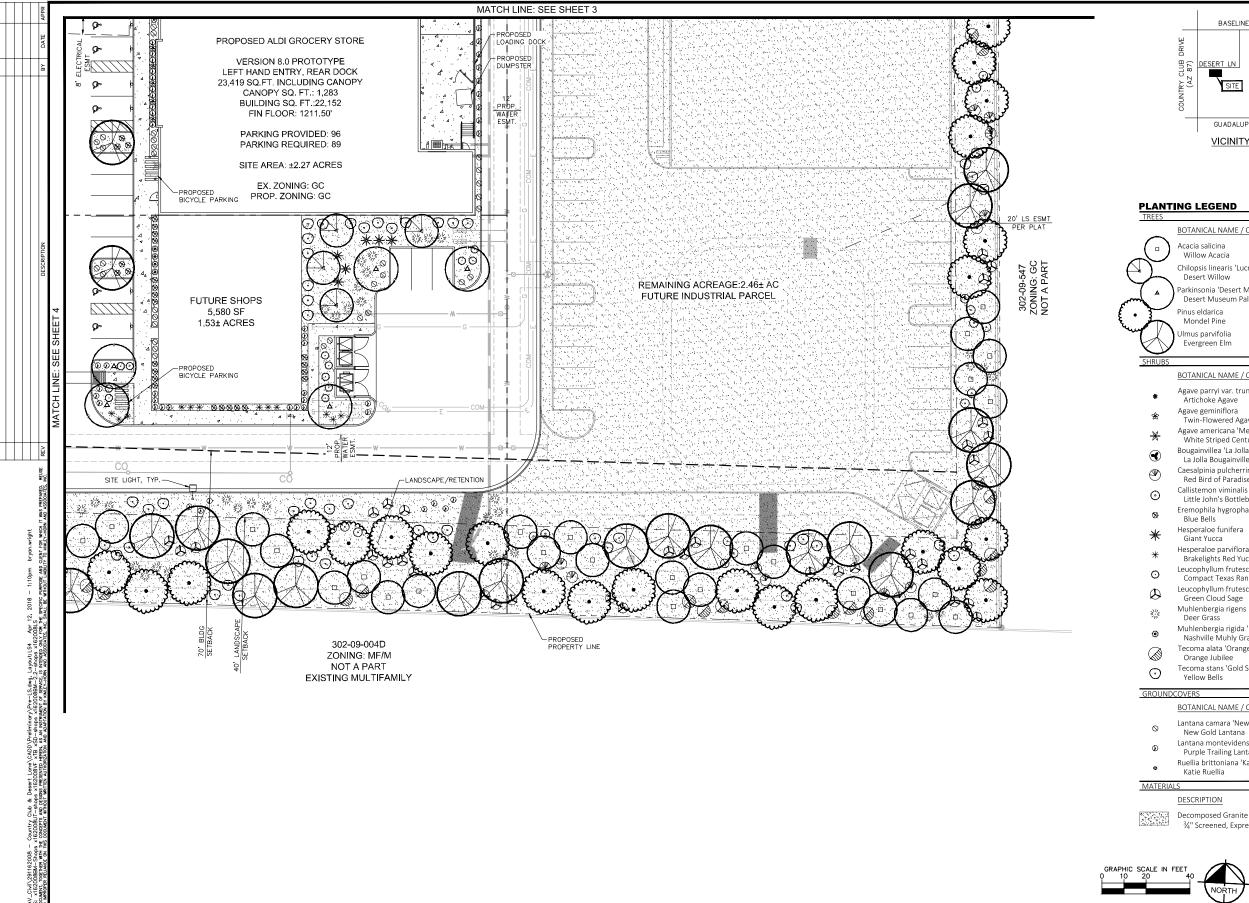



PLANTING LEGEND

BOTANICAL NAME / COMMON NAME

Pinus eldarica

Willow Acacia Chilopsis linearis 'Lucretia Hamilton' Desert Willow

Parkinsonia 'Desert Museum' Desert Museum Palo Verde

Mondel Pine mus parvifolia Evergreen Elm

BOTANICAL NAME / COMMON NAME

Agave parryi var. truncata Artichoke Agave

Agave geminiflora Twin-Flowered Agave

Agave americana 'Mediopicta Alba' White Striped Century Plant

Bougainvillea 'La Jolla'

La Jolla Bougainvillea Caesalpinia pulcherrima Red Bird of Paradise

Callistemon viminalis 'Little John' Little John's Bottlebrush

Eremophila hygrophana

Blue Bells Hesperaloe funifera

Giant Yucca Hesperaloe parviflora 'perpa' Brakelights Red Yucca

Leucophyllum frutescens 'Compacta' Compact Texas Ranger Sage

Leucophyllum frutescens 'Green Cloud' Green Cloud Sage

Muhlenbergia rigens Deer Grass

Muhlenbergia rigida 'Nashville' Nashville Muhly Grass

Tecoma alata 'Orange Jubilee' Orange Jubilee Tecoma stans 'Gold Star'

BOTANICAL NAME / COMMON NAME

Lantana camara 'New Gold' New Gold Lantana

Lantana montevidensis Purple Trailing Lantana

Katie Ruellia

3/4" Screened, Express Brown







Kimley » Horn

DC.



PRELIMINARY LANDSCAPE GILBERT, ARIZONA


291162008 SCALE (H): 1": 20' SCALE (V): NONE DRAWN BY: RAS

DESIGN BY: AAV CHECK BY: AAV DATE: 04/06/201



Expires 09/30/2018 LS4



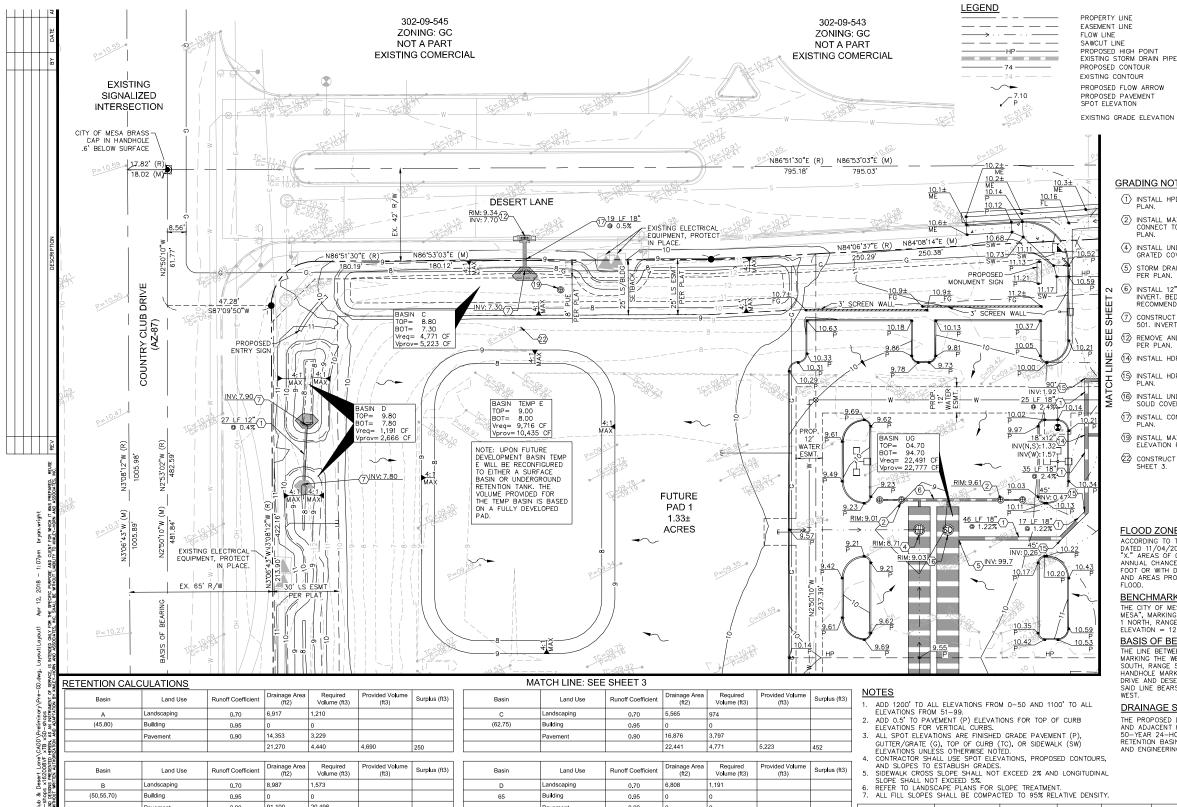

ETENTION CALCULATIONS								
Basin	Land Use	Runoff Coefficient	Drainage Area (ft2)	Required Volume (ft3)	Provided Volume (ft3)	Surplus (ft3)		
Α	Landscaping	0.70	6,917	1,210				
(45,80)	Building	0.95	0	0				
	Pavement	0.90	14,353	3,229				

	1 dromont	0.00		-,		
			21,270	4,440	4,690	250
Basin	Land Use	Runoff Coefficient	Drainage Area (ft2)	Required Volume (ft3)	Provided Volume (ft3)	Surplus (ft3)
В	Landscaping	0.70	8,987	1,573		
(50,55,70)	Building	0.95	0	0		
	Pavement	0.90	91,100	20,498		
			100,087	22,070	12,822	-9,248

Basin	Land Use	Runoff Coefficient	Drainage Area (ft2)	Required Volume (ft3)	Provided Volume (ft3)	Surplus (ft3)
Temp B	Landscaping	0.70	8,987	1,573		
60	Building	0.95	0	0		
	Pavement	0.90	91,100	20,498		
			100,087	9,248	9,690	442
IASIN 'TEMP B' IS TEMPORARY SUPLEMENTARY VOLUME FOR B. THE REQUIRED VOLUME IS THE DEFECIT IN BASIN						

Basin	Land Use	Runoff Coefficient	Drainage Area (ft2)	Required Volume (ft3)	Provided Volume (ft3)	Surplus (ft3)
С	Landscaping	0.70	5,565	974		
(62,75)	Building	0.95	0	0		
	Pavement	0.90	16,876	3,797		
			22,441	4,771	5,223	452

	Basin	Land Use	Runoff Coefficient	Drainage Area (ft2)	Required Volume (ft3)	Provided Volume (ft3)	Surplus (ft3)
	D	Landscaping	0.70	6,808	1,191		
ĺ	65	Building	0.95	0	0		
		Pavement	0.90	0	0		
ĺ				6,808	1,191	2,666	1,475

Basin	Land Use	Runoff Coefficient	Drainage Area (ft2)	Required Volume (ft3)	Provided Volume (ft3)	Surplus (ft3)
Temp E	Landscaping	0.70	0	0		
61	Building	0.95	0	0		
	Pavement	0.90	43,182	9,716		
			43,182	9,716	10,435	719

	Basin	Land Use	Runoff Coefficient	Drainage Area (ft2)	Required Volume (ft3)	Provided Volume (ft3)	Surplus (ft3)
	UG	Landscaping	0.70	3,805	666		
(ft3)	(5,10,15,25,40)	Building	0.95	22,153	5,261		
		Pavement	0.90	73,618	16,564		
				99.576	22.491	22.777	285
	NOTES.	1					

NUIES: TEMP BASIN E HAS BEEN SIZED FOR VOLUME FOR ULTIMATE PAD DEVELOPMENT AND WILL BE EITHER RECONFIGURED OR PLACED UNDERGROUND UPON DEVELOPMENT.

PROPERTY LINE BASELINE ROAD EASEMENT LINE FLOW LINE SAWCUT LINE PROPOSED HIGH POINT EXISTING STORM DRAIN PIPE DESERT LN PROPOSED CONTOUR EXISTING CONTOUR PROPOSED FLOW ARROW PROPOSED PAVEMENT SPOT ELEVATION

VICINITY MAP

GUADALUPE ROAD

- $\fbox{1}$ INSTALL HPDE PIPE. LENGTH, SIZE, AND SLOPE PER $_{\text{PI}}$ ANI
- (2) INSTALL MAXWELL PLUS DUAL CHAMBER DRYWELL AND CONNECT TO EQUALIZER PIPES. RIM ELEVATION PER
- (4) INSTALL UNDERGROUND RETENTION ACCESS RISER WITH GRATED COVER. RIM ELEVATION PER PLAN.
- (5) STORM DRAIN CONNECTION TO RETENTION TANK. INVERTING PER PLAN.
- (6) INSTALL 12" CMP EQUALIZER PIPES AT RETENTION TANK INVERT. BEDDING AND BACKFILL PER MANUFACTURER RECOMMENDATIONS.
- (7) CONSTRUCT CONCRETE HEADWALL PER MAG STD DET 501. INVERT PER PLAN.
- $\ensuremath{\textcircled{\sc 12}}$ REMOVE AND REPLACE EXISTING CATCH BASIN. INVERT PER PLAN.
- (14) INSTALL HDPE TEE. SIZE AND INVERT PER PLAN.
- (5) INSTALL HDPE BEND. SIZE, ANGLE, AND INVERT PER PLAN.
- (16) INSTALL UNDERGROUND RETENTION ACCESS RISER WITH (17) INSTALL CONCRETE PIPE. LENGTH, SIZE, AND SLOPE PER
- (19) INSTALL MAXWELL IV SINGLE CHAMBER DRYWELL. RIM ELEVATION PER PLAN.
- CONSTRUCT 4' WIDE CURB OPENING PER DETAIL ON SHEET 3.

ACCORDING TO THE FLOOD INSURANCE RATE MAP #04013C2727L, DATED 11/04/2015, THIS PROPERTY IS LOCATED IN FLOOD ZONE "X." AREAS OF 0.2% ANNUAL CHANCE FLOOD; AREAS OF 1% ANNUAL CHANCE FLOOD WITH AVERAGE DEPTHS OF LESS THAN 1 FOOT OR WITH DRAINAGE AREAS LESS THAN 1 SQUARE MILE; AND AREAS PROTECTED BY LEVEES FROM 1% ANNUAL CHANCE FLOOD.


THE CITY OF MESA BRASS CAP IN HANDHOLE STAMPED "CITY OF MESA", MARKING THE NORTH QUARTER OF SECTION 34, TOWNSHIP NORTH, RANGE 5 EAST, GØSRBM. TOWN OF GILBERT DATUM. ELEVATION = 1213.60 (NAVD '88)

BASIS OF BEARING

THE LINE BETWEEN A CITY OF MESA BRASS CAP IN HANDHOLE MARKING THE WEST QUARTER CORNER OF SECTION 3, TOWNSHIP SOUTH, RANGE 5 EAST, AND A CITY OF MESA BRASS CAP IN HANDHOLE MARKING THE INTERSECTION OF S. COUNTRY CLUB DRIVE AND DESERT LANE.

SAID LINE BEARS NORTH 2 DEGREES 50 MINUTES 10 SECONDS WEST.

DRAINAGE STATEMENT: THE PROPOSED DEVELOPMENT MIL RETAIN ALL ON—SITE AND ADJACENT HALF—STREET FLOWS GENERATED FROM THE 50—YEAR 24—HOUR STORM IN SURFACE AND UNDERGROUND RETENTION BASINS PER TOWN OF GILBERT PUBLIC WORKS

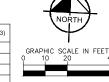



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PLAN

291162008

SCALE (H): 1": 20' SCALE (V): NONE DRAWN BY: BMW ESIGN BY: BMW CHECK BY: STM

DATE: 04/06/201

GD1

- $\stackrel{\textstyle \frown}{}$ INSTALL HPDE PIPE. LENGTH, SIZE, AND SLOPE PER PLAN.
- (2) INSTALL MAXWELL PLUS DUAL CHAMBER DRYWELL AND CONNECT TO EQUALIZER PIPES. RIM ELEVATION PER PLAN.
- $\overleftarrow{\mbox{5}}$ storm drain connection to retention tank. Invert per plan.
- (6) INSTALL 12" CMP EQUALIZER PIPES AT RETENTION TANK INVERT. BEDDING AND BACKFILL PER MANUFACTURER RECOMMENDATIONS.
- $\stackrel{\textstyle \frown}{\bigcirc}$ Construct concrete Headwall per mag std det 501. Invert per Plan.
- $\ensuremath{\bigcirc}$ Connect to building drain, ref arch plans. Invert PER PLAN.
- $\ensuremath{\fbox{1}}\xspace$ transition pavement along curb from 6" reveal to flush with top of curb.
- $\ensuremath{\bigcirc}$ REMOVE AND REPLACE EXISTING CATCH BASIN. INVERT PER PLAN.
- $\begin{tabular}{lll} \hline $\langle \end{tabular} \begin{tabular}{lll} \hline $\langle \end{tabular} \begin{tabular}{lll} \hline $\langle \end{tabular} \begin{tabular}{lll} \hline & \end{tabular} \begin{tabula$
- 14 INSTALL HDPE TEE. SIZE AND INVERT PER PLAN.
- $\ensuremath{\mbox{(5)}}$ INSTALL HDPE BEND. SIZE, ANGLE, AND INVERT PER PLAN.
- (6) INSTALL UNDERGROUND RETENTION ACCESS RISER WITH SOLID COVER. RIM ELEVATION PER PLAN.
- CONSTRUCT 4' WIDE CURB OPENING PER DETAIL ON SHEET 3.
- 4" BUILDING DRAIN TO UNDER DRAIN.

BASELINE ROAD

GUADALUPE ROAD VICINITY MAP

DESERT LN

CLUB (87)

- 1 FLUSH CONCRETE, REF ARCH PLANS.

- $\ensuremath{\overline{\text{(1)}}}$ INSTALL CONCRETE PIPE. LENGTH, SIZE, AND SLOPE PER PLAN.
- (19) INSTALL MAXWELL IV SINGLE CHAMBER DRYWELL. RIM ELEVATION PER PLAN.

291162008

Kimley » Horn

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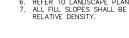
PLAN

GRADING AND DRAINAGE

SCALE (H): 1": 20' SCALE (V): NONE DRAWN BY: BMW DESIGN BY: BMW

CHECK BY: STM DATE: 04/06/201

4690 22,512 5,223 2,666 0.1 22,777 UG 25,410





1. TEMP BASINS E AND F ARE ONE FOOT IN DEPTH AND SHALL NATURALLY PERCOLATE.



PROPOSED CONTOUR EXISTING CONTOUR


PROPOSED PAVEMENT SPOT ELEVATION

PROPOSED FLOW ARROW

EXISTING GRADE ELEVATION





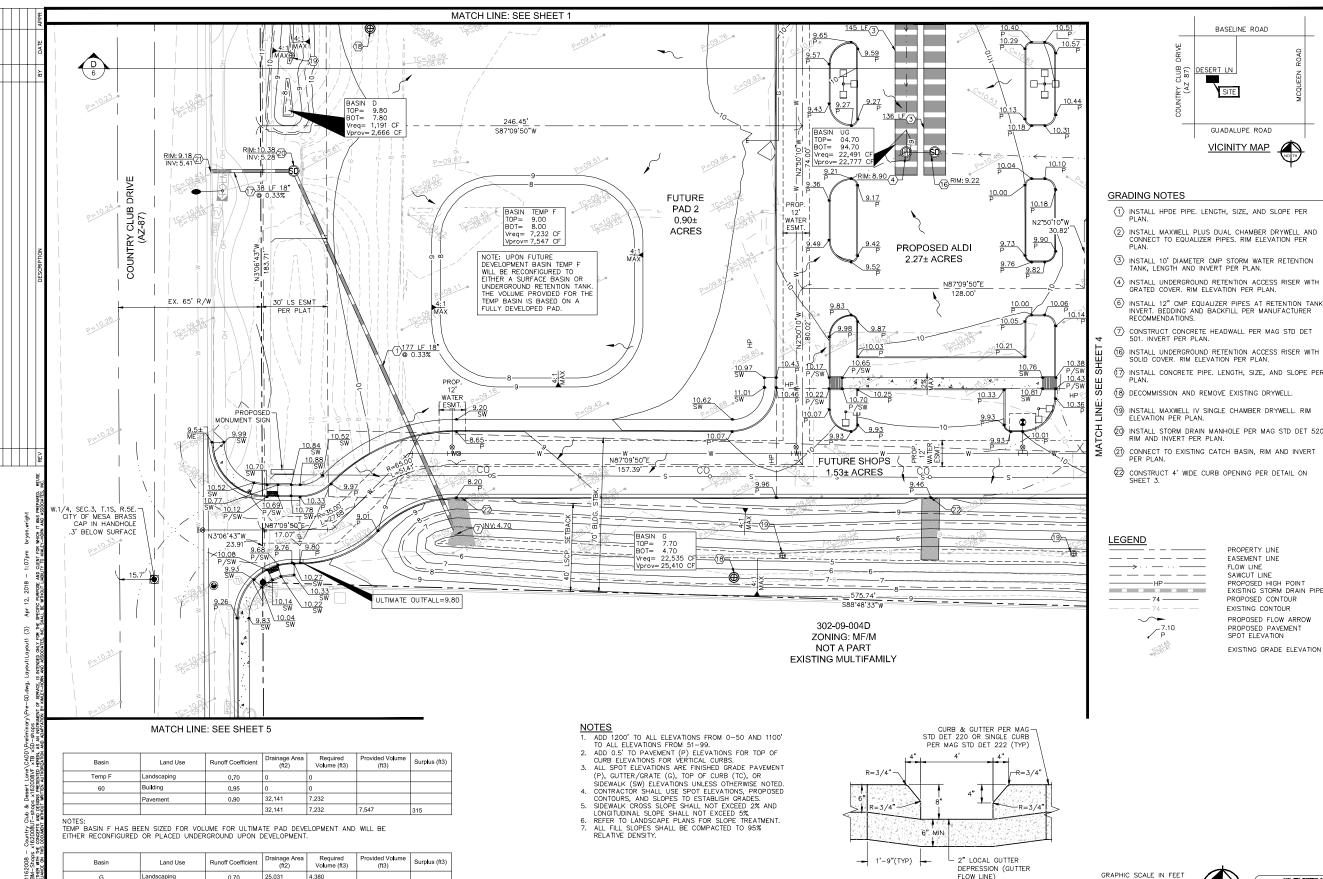

(20,30,32,33,35,57,58)

Building

vement

0.95

0.90

80,686

105,717

18,154

22,535

2,875

BASELINE ROAD GUADALUPE ROAD VICINITY MAP

- 1 INSTALL HPDE PIPE. LENGTH, SIZE, AND SLOPE PER PLAN.
- (2) INSTALL MAXWELL PLUS DUAL CHAMBER DRYWELL AND CONNECT TO EQUALIZER PIPES. RIM ELEVATION PER PLAN.
- (3) INSTALL 10' DIAMETER CMP STORM WATER RETENTION TANK, LENGTH AND INVERT PER PLAN.
- $\stackrel{\textstyle \leftarrow}{4}$ install underground retention access riser with grated cover. Rim elevation per plan.
- (6) INSTALL 12" CMP EQUALIZER PIPES AT RETENTION TANK INVERT. BEDDING AND BACKFILL PER MANUFACTURER RECOMMENDATIONS.
- (7) CONSTRUCT CONCRETE HEADWALL PER MAG STD DET 501. INVERT PER PLAN.
- (6) INSTALL UNDERGROUND RETENTION ACCESS RISER WITH SOLID COVER. RIM ELEVATION PER PLAN
- 17 INSTALL CONCRETE PIPE. LENGTH, SIZE, AND SLOPE PER
- $\ensuremath{\textcircled{19}}$ install maxwell iv single chamber drywell. Rim elevation per plan.
- (20) INSTALL STORM DRAIN MANHOLE PER MAG STD DET 520, RIM AND INVERT PER PLAN.
- ② CONNECT TO EXISTING CATCH BASIN, RIM AND INVERT PER PLAN.

CURB OPENING DETAIL

PROPERTY LINE EASEMENT LINE FLOW LINE SAWCUT LINE PROPOSED HIGH POINT EXISTING STORM DRAIN PIPE PROPOSED CONTOUR EXISTING CONTOUR PROPOSED FLOW ARROW PROPOSED PAVEMENT SPOT ELEVATION

291162008

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PLAN

DRAINAGE

AND

GRADING

GILBERT,

SCALE (H): 1": 20' SCALE (V): NONE DRAWN BY: BMW DESIGN BY: BMW


CHECK BY: STM DATE: 04/06/201

47183 STERLING MARGETTS

GD3

602-263-1100

I-800-STAKE-IT

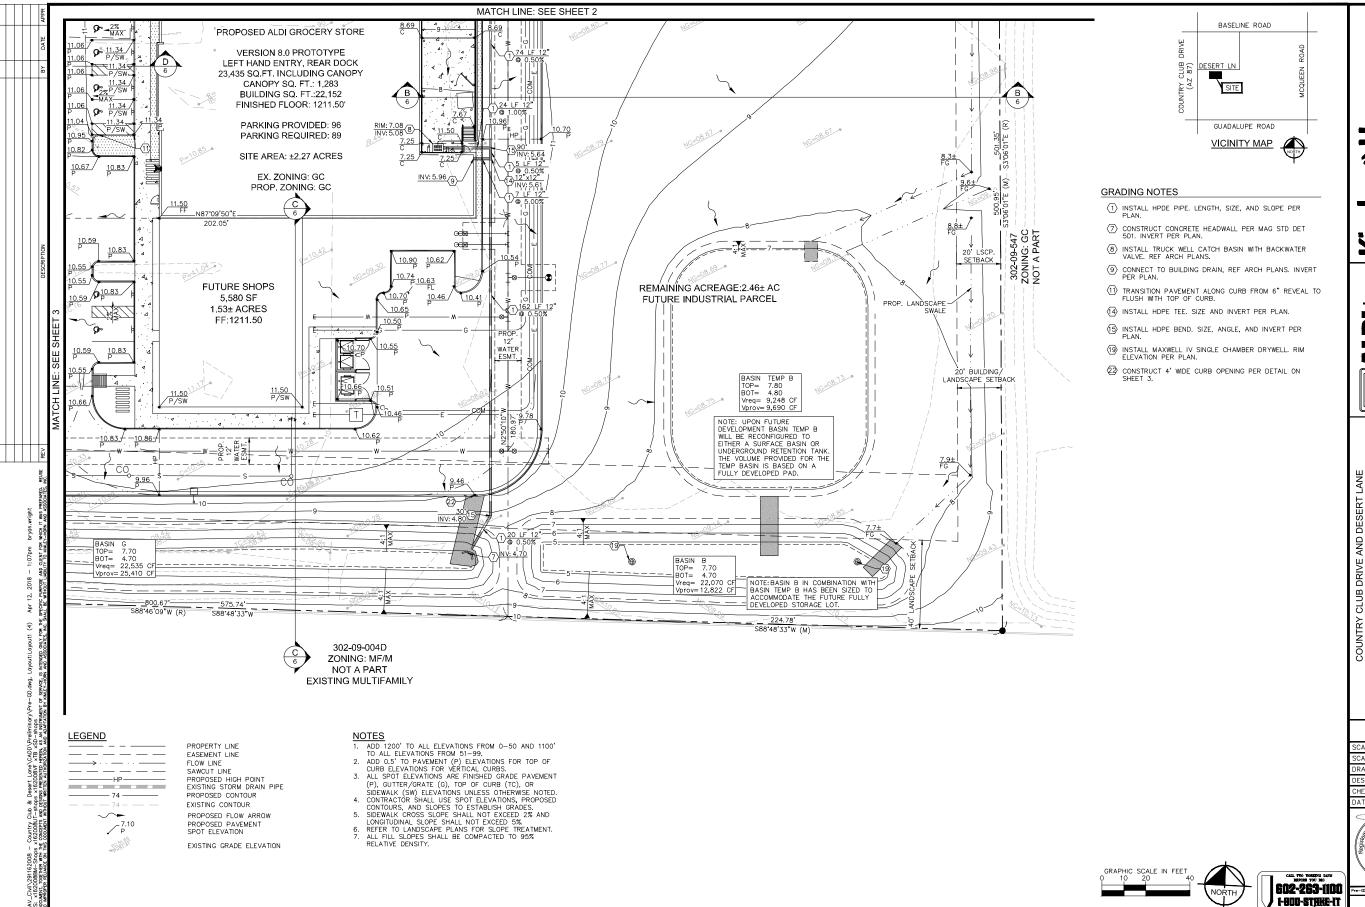

KimleyMorn

| DC |... STE. 335 |2. 85018 |8931 ALDI

GRADING AND DRAINAGE PLAN CLUB DRIVE AND DESERT **PRELIMINARY**

291162008

SCALE (H): 1":20' SCALE (V): NONE DRAWN BY: BMW DESIGN BY: BMW

CHECK BY: STM

DATE: 04/06/201




GD4



602-263-1100
1-800-8TRHE-IT

Pre-GD.dwg

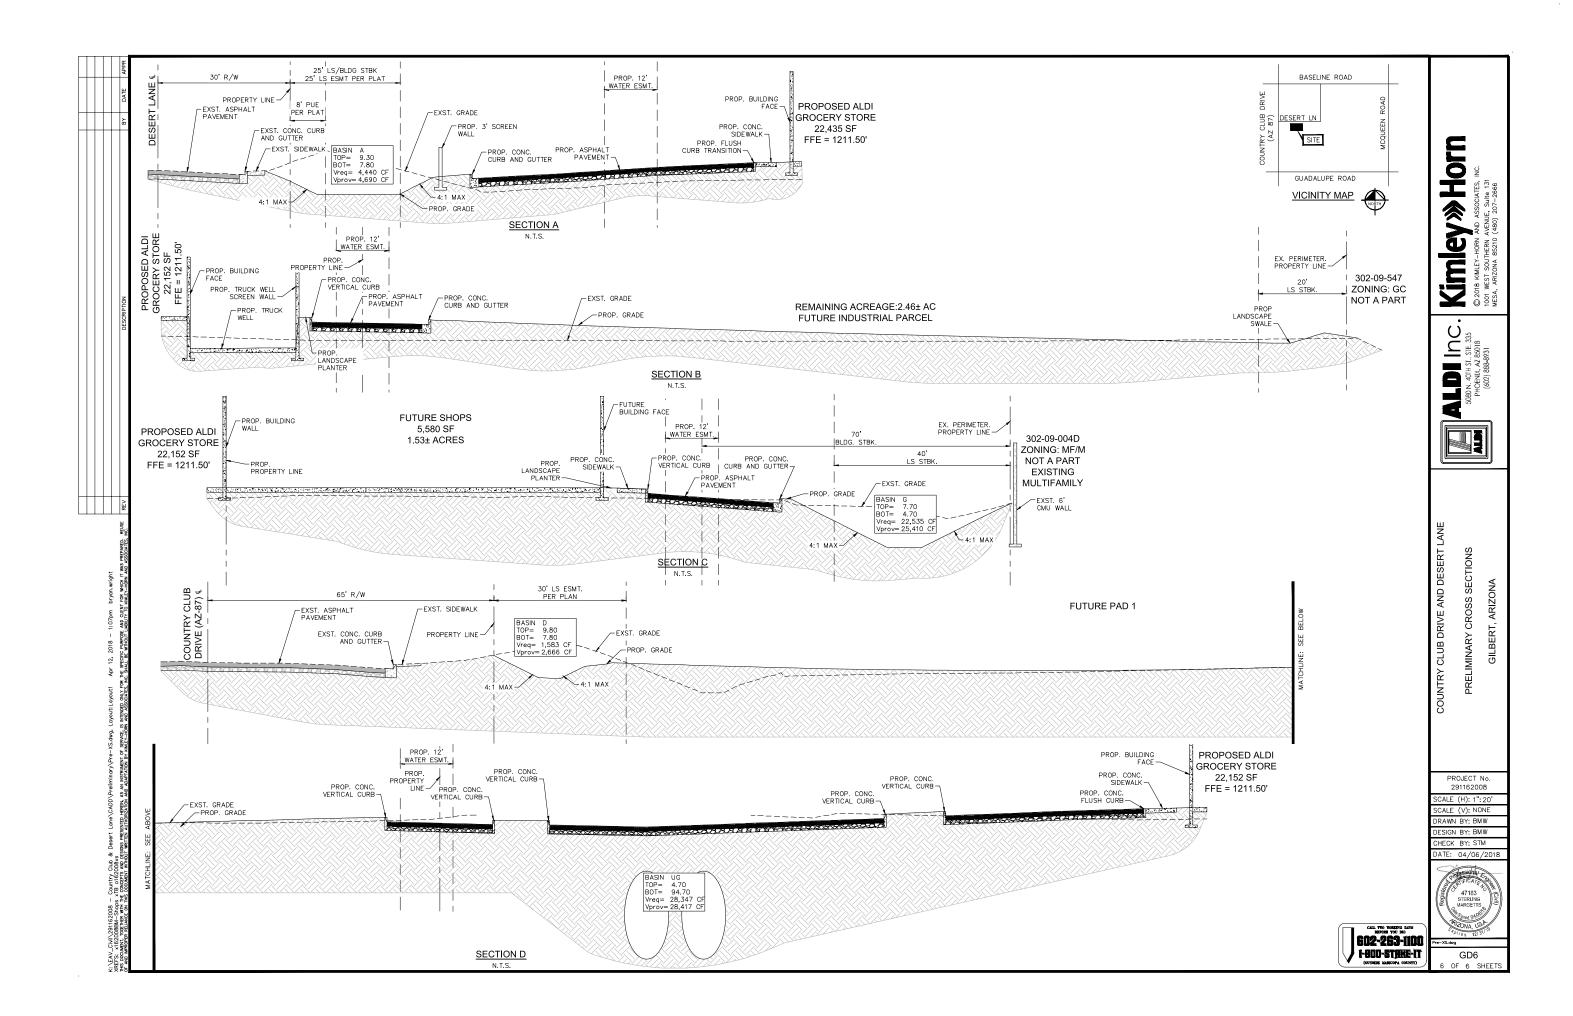

DR18-56: ALDI Attachment 5 - Building Elevations June 6, 2018



	EXTERIOR FINISH SCHEDULE				
KEY	MATERIAL / MFG.	COLOR / NO.	NOTES		
(Al)	PREFINISHED METAL COPING	A1- SILVER - AT HIGH ROOF & CANOPY A1a - SIERRA TAN - AT BRICK A1b - AGED BRONZE - AT NICHIHA TOWERS A1c-GRANITE - AT EIFS	SEE SPECIFICATIONS APPENDIX 'B'		
(A2)	SPEC-BRICK CONCRETE MASONRY VENEER	4 x 4 x 16 GARDNER BLEND W/ HOLCIM "SANDBEIGE" MORTAR	CONTACT THE CONCRETE PRODUCTS GROUP AT 800-789-0872 FOR ORDERING SEE SPEC FOR ADDITIONAL INFO		
(A3)	PREFINISHED ALUM. SILL	BRIGHT SILVER			
(A4)	ALUMINUM STOREFRONT - FRONT SET GLAZING	ANODIZED ALUM.	SHADED WINDOWS ARE SPANDREL RE: DWG. A602		
(A5)	MEMBRANE ROOFING	GRAY	TOP OF SLOPED ROOF, CANOPY ROOF, AND BACK OF RAISED ROOF PROJECTIONS - SEE SPECIFICATIONS APPENDIX 'B'		
(A6)	METAL SOFFIT PANELS	SOLID PANELS - BRIGHT SILVER	RE: DWG. A301-A304		
(A7)	EXTERIOR PAINT	PT-19 / CL-9	RE: DWG. A603		
(A8)	KALWALL	EXT. FACE: CRYSTAL, INTERIOR FACE: WHITE 25	070 TYPE A		
(A9)	ALUMINUM COMPOSITE PANEL	BRIGHT SILVER (NON-REFLECTIVE)	PROVIDE PANEL JOINTS AS SHOWN - PROVIDE ONE PIECE TIGHT FIT EXTRUDED MOLDING INSTALLATION SYSTEM WITH CENTER REVEAL TRIM BETWEEN PANELS AND J TRIM AT PANEL EDGES.		
(A10)	NICHIHA FIBER CEMENT EXTERIOR CLADDING	VINTAGEWOOD 'BARK'	CONTACT NICHIHA AT 770-805-9466 FOR ORDERING SEE SPEC FOR TRIM REQUIREMENTS AND ADDITIONAL INFO		
<u>(AII)</u>	BLRD-2	PT-19 / CL-4	RE: DWG A603		
(A12)	BLRD-4	STAINLESS STEEL	RE: DWG A603		
(A13)	PREFABRICATED SUN SHADE	SILVER POWDER COAT	MANUFACTURED BY C. R. LAURENCE; RE: DWGS A306, A505		
(A14)	GUARD RAIL TYPE "B"	PT-19 / CL-9	RE: DWG B2/A507, A603		
(A15)	CART STARTER POST	GALVANIZED			
(A16)	DOCK LEVELER / SEAL AND BUMPERS	LEVELER - FACTORY FINISH / SEAL AND	PROVÍDE BRÍCK BEHIND DOCK SEAL		
(A17)	MASONRY CONTROL JOINT	BUMPERS - FACTORY FINISH - BLACK	MAX 30' OC RE: DWG. A504, A505		
(A18)		PT-19 / CL-9	RE: DWG A2/A507		
픚	OVERFLOW SCUPPER	TBD - NATURAL CONCRETE LOOK	RE. DWG AZ/AGU/		
(A19)	ARCHITECTURAL CAST STONE CAP		7'-11 1/8" w. x 9'-5 1/2" h.; VERIFY SIGN SIZE PRIOR TO FRAMING OPENING		
<u>(20)</u>	ALDI TOWER SIGN	BY SIGN VENDOR	SEE DETAIL C1/A504		
<u>(21)</u>	CRTB	NATURAL	RE: DWG A603 - SEE STRUCTURAL DWGS		
(422)	KNOX BOX	FACTORY FINISH	CONFIRM TYPE AND LOCATION WITH LOCAL FIRE MARSHAL		
(A23)	FIBER CEMENT PANEL CORNER TRIM	FINISH TO MATCH PANELS	TYPICAL AT ALL OUTSIDE CORNERS		
(A24)	FIBER CEMENT PANEL VERTICAL JOINT				
(A25)	8" X 8" PRE-FINISHED ALUM GUTTER				
(A26)	8" X 8" PRE-FINISHED ALUM DOWNSPOUT		TERMINATE AT CONC. SPLASH BLOCK		
(427)	ACP H/J TRIM / JOINT COVER		TYPICAL AT EDGES AND BUTT JOINTS OF ACP		
<u>(28)</u>	NICHIHA FIBER CEMENT PANEL BASE FLASHING	TO MATCH NICHIHA BARK TRIM	COLOR BASED ON NICHIHA TRIM PAINT FORMULA; OBTAIN FROM NICHIHA		
(A29)	DRYVIT SYSTEMS, INC EXTERIOR INSULATION FINISH SYSTEM	SANDPEBBLE FINE DPR COLOR #104 DOVER SKY	SEE SPEC FOR ADDITIONAL INFO		
(A30)	DUMPSTER ENCLOSURE		RE. DWG A507		
(A31)	EXTERIOR CMU PAINT	TO MATCH VINTAGEWOOD NICHIHA 'BARK'			
(A32)	ROOF SCREEN	CITYSCAPES ENVISOR, COLOR: SLATE GRAY	REFER TO SPECIFICAITONS.		
E	EXIT DISCHARGE LIGHT	FACTORY FINISH	MOUNT @ 8'-0" A.F.F.		
E2	WALL SCONCE	FACTORY FINISH	MOUNT @ 16'-2" A.F.F.; RE: DWG. A111 FOR DIMENSIONS		
E3	FUSED DISCONNECT	FACTORY FINISH	SEE ELECTRICAL DWGS		
E4)	UTILITY METERING & C.T.	FACTORY FINISH	SEE ELECTRICAL DWGS		
E5)	EXTERIOR WALL PACK	FACTORY FINISH	MAN DOORS - MOUNT @ 9'-0" A.F.F. LOADING DOCK - MOUNT @ 12'-0" A.F.F.		
E6)	EXTERIOR DUPLEX RECEPTACLE	FACTORY FINISH	MOUNT @ 1'-5" A.F.F. IN 4" SQUARE J-BOX		
FI	FIRE DEPT. CONNECTION	FACTORY FINISH	SEE FIRE PROTECTION DWGS		
F2)	MOTOR GONG	FACTORY FINISH	SEE FIRE PROTECTION DWGS		
<u>O</u>	HOSE BIB	FACTORY FINISH	SEE PLUMBING DWGS		
P2)	RPZ DISCHARGE	FACTORY FINISH	SEE PLUMBING DWGS		
$\frac{\mathcal{E}}{\langle x \rangle}$	GLAZING KEY		RE: DWG A602		
$\stackrel{\sim}{-}$			A: ALIGN NICHIHA PANEL JOINTS AND WINDOW MULLIONS		
\\\\	ALIGN KEY		B: ALIGN NICHIHA PANEL JOINTS, KALWALL MULLIONS & WINDOW MULLIONS C: NICHIHA PANEL JOINTS		

Revisions: Seal

Issued:

Concept No. 1

Date: 04/10/18

Date:

ms consultants, inc.

DO NOT SCALE PLANS

engineers, architects, planners 2221 Schrock Road Columbus, Obio 43229-1547 phone 614,898,7570 fax 614,898,7570

JSR

ALDI Inc.

ALDI Inc. Store #: 159 Gilbert

Country Club & Desert Lane Gilbert, AZ


Project Name & Location:

Exterior Elevation Material Schedule Drawing Name:

Prototype Rls. 02/07/18 Project No. 40464-05 Type: RHRD-V8

A-202

Scale: As Noted

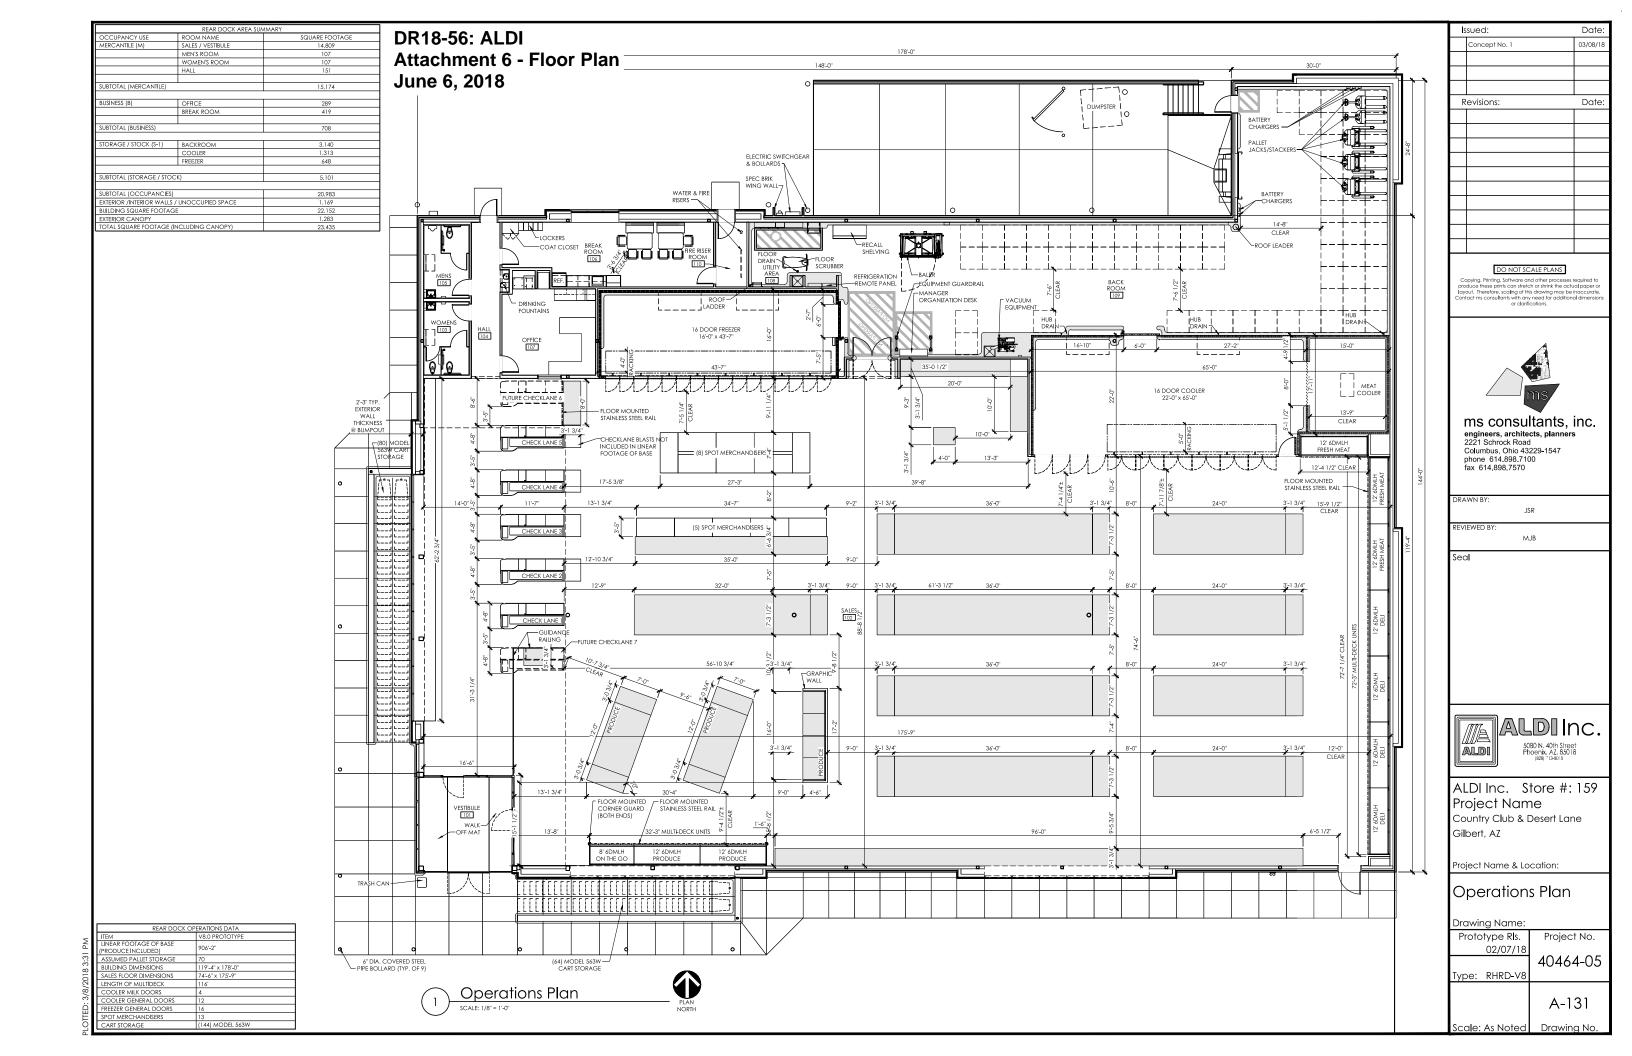

DR18-56: ALDI Attachment 7 - Lighting Photometric Plan June 6, 2018 EQUIPMENT SCHEDULE: (15) GL-SSP-4011-22-D6-PS (22' x4" SQ POLE, QUAD MOUNT) (35) GSQ-DACS DIRECT ARM MOUNT PROPOSED POLES MEET 100MPH SUSTAINED WIND LOADS Date:4/5/2018 Scale: 1"=40' Footcandles calculated at grade
Filename: V:Common/AppEng:NATALD-180305GLAZCJBR2.AGI Layout by: CHRIS BOSANEC DR18-56: ALDI Attachment 8 - Colors and Materials June 6, 2018

